Erosion and Sediment Control Schedule

Ingress—Egress
A stone access drive complete with under lying geo—textile fabric (20 feet wide and 50 feet long) for ingress and egress at the site shall be installed. This drive shall be the only entrance and exit to the site.

Silt Fence
A silt fence shall be installed prior to any earthwork activities at the site in the locations shown on the site plan as well as along the front of any lot that slopes towards the street.

Temporary Seeding
Disturbed areas of the site that are to remain idle for more than twenty-one(21) days shall be properly seeded and straw mulched within seven(7) days of completion of intitial grading.

Temporary seeding and mulching as a thirty(30) foot strip of the entire front of the lot shall be maintained on the site once initial grading is complete.

Stabilization of critical areas within fifty(50) feet of any stream or wetland shall be complete within two(2) days of the disturbance if the site is to remain inactive for longer than fourteen(14) days.

Mulching
Straw—mulch shall be applied at a rate of 1 bale per every ten
(10) feet of curb, at a width of thirty(30) feet to the entire length of the lot. Wood chips may also be used but must be spread at a minimum depth of four inches over the thirty—foot width and must be accompanied by a properly installed silt

Erosion and sediment controls shall be inspected every seven(7) days or within 24 hours of a 0.5" or greater rainfall event. Necessary repairs shall be made at this time.

50

ROAD

F. 488.5


BSMT 679.1

2-170-0 GAL SEPTIC TANKS

HYDRAULIC PROFILE


SOLITTER


1082:1-20' VECT:1-51

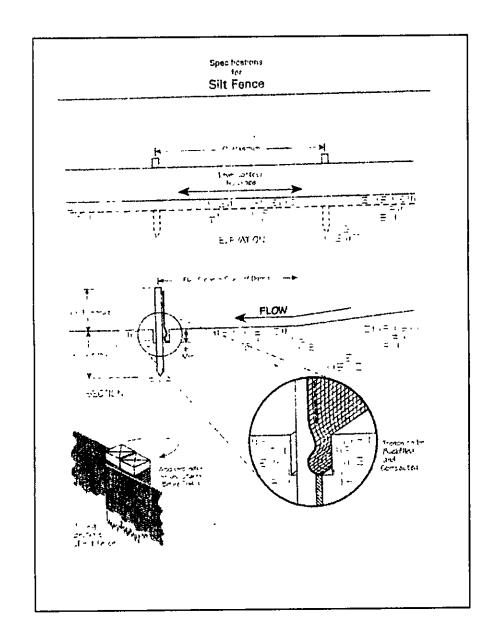



Seeding Dates	Species	Lb./1,000 ft. <sup>2</sup>	Per Ac.
March 1 to August 15	Oats	з .	4 bushet
	Tall Fescue	1	40 lb.
	Annual Ryegrass		40 lb.
	Perennial Ryegrass	1	40 lb.
	Tall Fescue	3	40 lb.
	Annual Ryegrass	1	40 lb.
Augus: 16 to November 1	Rye	3	2 bushel
	Tell Fescue	1	40 lb.
	Annual Ryegrass	1	40 lb.
	Wheat	3	2 bushel
	Tall Fescue	1	40 lb.
	Annual Ryegrass	1	40 lb.
	Perennial Ryegrass	1	40 lb.
	Tall Fescue	1	40 lb.
	Annual Ryegrass	1	40 lb.



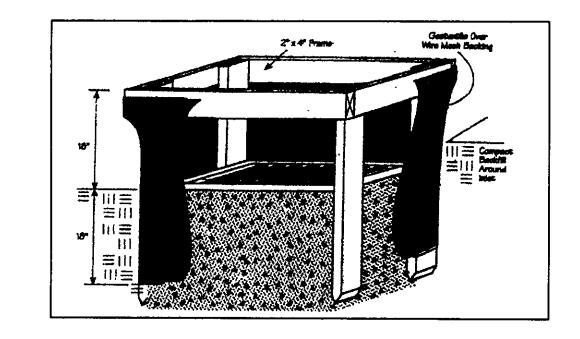

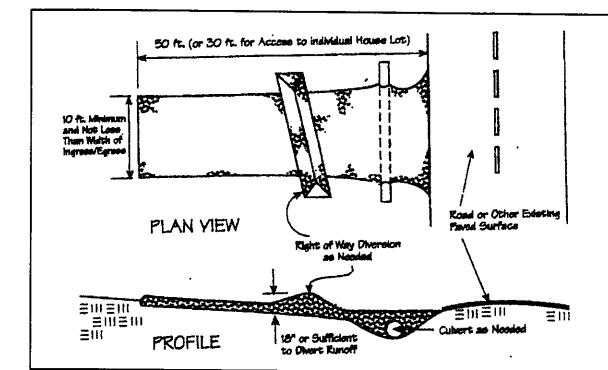

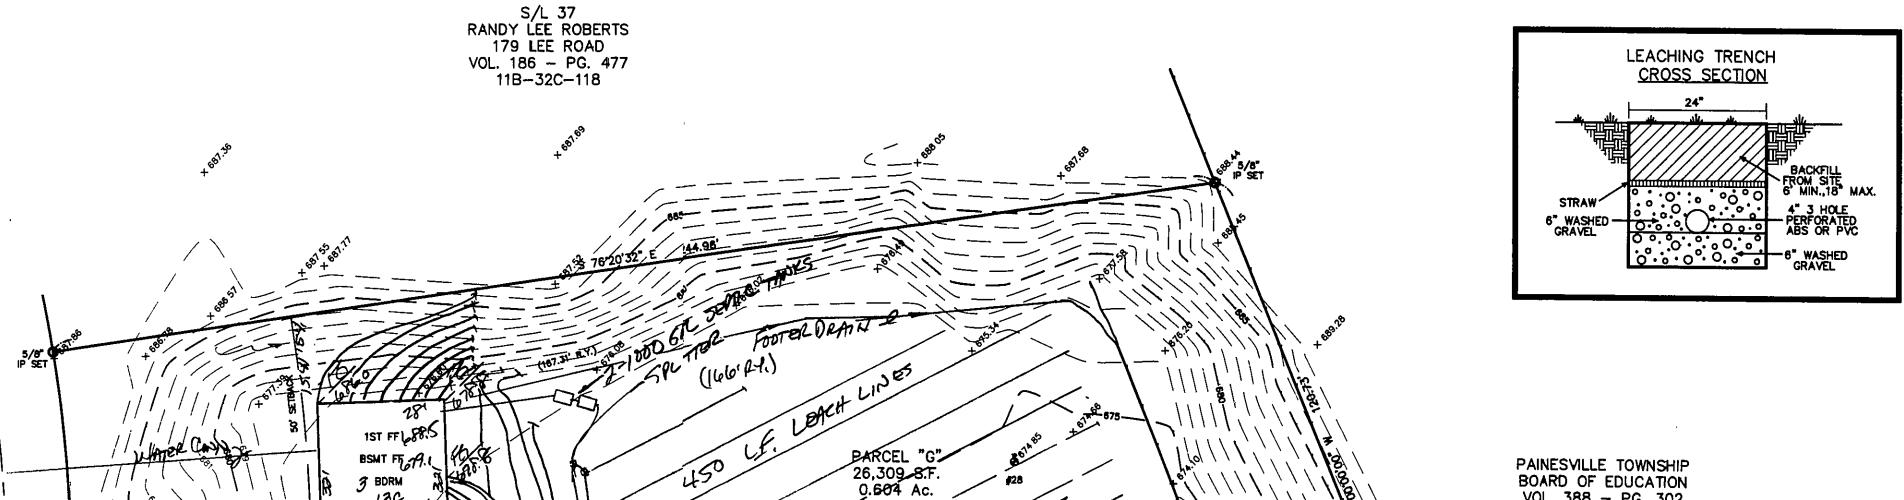

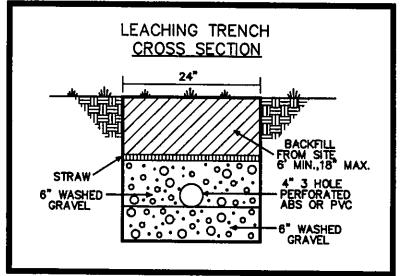

PAINESVILLE TOWNSHIP BOARD OF EDUCATION VOL. 388 - PG. 302 11B-32-1

LAKE COUNTY GENERAL. HEALTH DISTRICT

REVIEWED AND ACCEPTED

Sewaje disposal Permit Must be Obtained by a Lake County Licensed Installer before Install/ Tich is Starfed Control of the Contro

"i, the undersigned hereby certify that this topography indicated by 6", 1', or 2' contours, and elevations shown hereon appropriate intervals and that as of that date they existed as indicated hereon."

Management Plan AMES R. GILLS, P.E. County Drainage Engineer Strate 0 Divert water as shown

TBM - T.S.F.H. ELEV - 690.37

CURVE TABLE CURVE LENGTH RADIUS TANGENT CHORD BEARING DELTA C1 77.73 280.00 39.11 77.48 N20°25'07"E 15°54'18" C2 683.27 255.00 1083.99 496.45 S74°21'58"E 153°31'28"

EXISTING UTILITIES NOTE:
THE SIZE AND LOCATION, BOTH HORIZONTAL AND VERTICAL
OF THE UNDERGROUND UTILITIES SHOWN HEREON, HAVE BEEN
OBTAINED BY A SEARCH OF AVAILABLE RECORDS.
VERIFICATION BY FIELD OBSERVATION HAS BEEN CONDUCTED
WHERE PRACTICAL, HOWEVER, BABCOCK, JONES AND ASSOCIATES
INC. DOES NOT GUARANTEE THE COMPLETENESS NOR ACCURACY
THEREOF.

LEE ROAD

LAKE COUNTY



REV NO.	DESCRIPTION	DATE	BY	CHK'D
1	REVISED PERLC HARTH DAT	7-31-06	1.8	187
2		7-2-06	149	775
3	LEXSED FOUNDATION.	8-75-26	1/1	00
				L



N66'43'12" W + 275.94'

PARCEL "F" (VACANT)

BABCOCK, JONES AND ASSOCIATES, INC. CIVIL ENGINEERS - SURVEYORS - LAND PLANNERS

DATE	7/25/06	
DESIGN BY	H.J.	
DRAWN BY	B.P.	TED LYNDALL -
APPROVED BY	H.J.	PA
CREW CHIEF	W.B.	PAINESVILLE TOWNSHIP

GRAPHIC SCALE

( IN FEET )

1 inch = 20 ft.

SITE PLAN TED LYNDALL - LAKE COUNTY BUILDERS SUPPLY

PARCEL "G"

1"=20' JOB NO 06-115-G

PAINESVILLE OHIO 44077

STATE OF OHIO